

## PROJECT INFORMATION

BOZEMAN, MT

PROJECT ADDRESS: 1059 N 12TH AVENUE

LEGAL DESCRIPTION: LOT 13, BLOCK 1
OAK MEADOWS SUBDIVISION

BUILDING AREA: MAIN (HEATED): 1,723 SF GROSS (INC. EXT. WALLS)
GARAGE: 529 SF NET

## **GENERAL NOTES**

- WRITTEN DIMENSIONS SHALL HAVE PRECEDENCE OVER SCALED DIMENSIONS. DO NOT
- SCALE THE DRAWINGS.
  ALL WORK SHALL COMPLY WITH APPLICABLE CODES LISTED.
- ALL MATERIALS SHALL BE INSTALLED ACCORDING TO MANUFACTURER'S RECOMMENDATIONS UNLESS NOTED OTHERWISE.
- 4. ALL ELECTRICAL AND PLUMBING WORK SHALL BE INSTALLED BY LICENSED PROFESSIONAL(S) AND SHALL CONFORM WITH CURRENT CODES.
- CONFIRM AND COORDINATE LOCATIONS OF ALL UTILITIES WITH CONTRACTOR.
   CONTRACTOR SHALL NOTIFY DESIGNER IMMEDIATELY OF ANY DESCREPENCIES IN THE

INFORMATION CONTAINED IN THIS DRAWING SET HAS BEEN PREPARED FOR THE USE OF A PROFESSIONAL, LICENSED CONTRACTOR WHO IS FAMILIAR WITH BUILDING CODE AND OTHER LEGAL REQUIREMENTS WITHIN THE PROJECT'S JURISDICTION. NO WARRANTIES, EXPRESSED OR IMPLIED, ARE GIVEN OR INTENDED BY THE PREPARATION OF THESE DRAWINGS

ADOPTED CODES:

2012 INTERNATIONAL RESIDENTIAL CODE (IRC) 2012 UNIFORM PLUMBING CODE (UPC) 2012 INTERNATIONAL MECHANICAL CODE (IMC) 2014 NATIONAL ELECTRIC CODE (NEC) 2012 INTERNATIONAL FUEL GAS CODE (IFGC) 2012 INTERNATIONAL ENERGY CONSERVATION CODE (IECC)



DECIDUOUS STREET TREE

DECIDUOUS TREE

SMALL SHRUB


FLOWERING SHRUB

OKINAIVILIA DE GRASSES


PERENNIAL FLOWERS

SOD

PLANTING BED (WASHED ROCK) W/ PLASTIC OR METAL EDGING

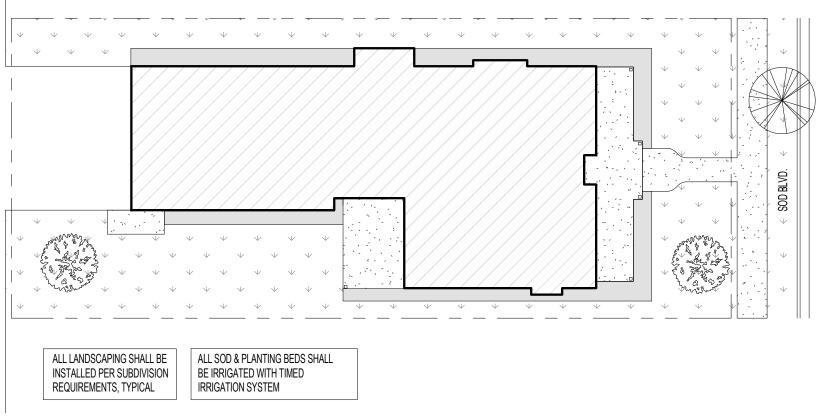

3 LANDSCAPE PLAN 1/16" = 1'-0"

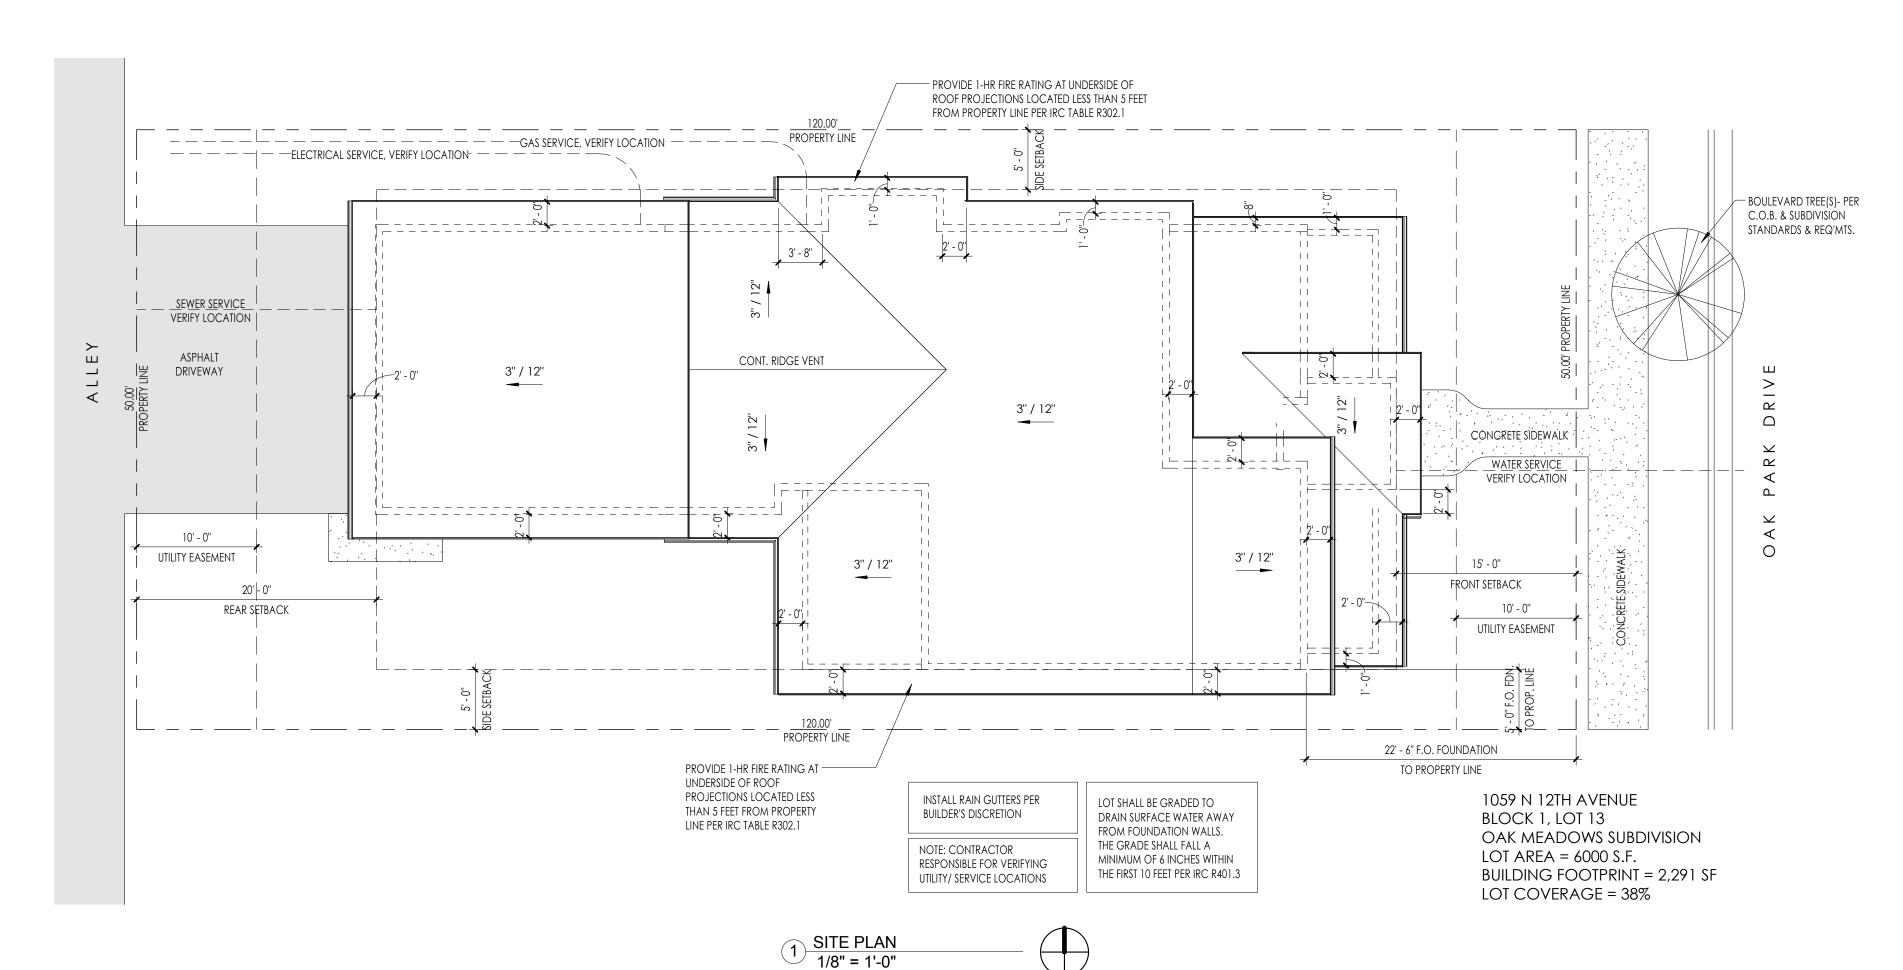

IRONWOOD DEVELOPMENT 406-581-9999

1059 N 12TH AVE. BLOCK 1, LOT 13 OAK MEADOWS SUB. BOZEMAN MT

REVISIONS:

NO. DESCRIPTION DATE

PROJECT NUMBER:

DRAWN BY / CHECKED BY: TPMP

1431

DATE: APRIL 7, 2015

PHASE: REVIEW SET

DRAWING TITLE:

SITE PLAN

DRAWING NUMBER:

**A1.1** 

77' - 6"

1 MAIN LEVEL 1/4" = 1'-0"

6' - 0"

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CONSERVATION CODE (IECC)

# **IRONWOOD DEVELOPMENT** 406-581-9999

1059 N 12TH AVE.

BLOCK 1, LOT 13

OAK MEADOWS SUB.

**BOZEMAN MT** 

## **CONSTRUCTION NOTES**

- EXTERIOR WALLS SHALL BE CONSTRUCTED OF 2x6 STUDS @ 16" o.c. WITH R-21 INSULATION, UNLESS NOTED OTHERWISE. ALL EXTERIOR SHEATHING TO BE 1/2" NOMINAL CONTINUOUS STRUCTURAL RATED PANEL.
- INTERIOR WALLS SHALL BE CONSTRUCTED OF 2x4 STUDS @ 16" o.c., UNLESS NOTED OTHERWISE. PROVIDE 2x6 WALLS AT ALL POCKET DOORS. INTERIOR WALLS TO RECEIVE 1/2" GYP BD, UNLESS NOTED OTHERWISE.
- FLOOR JOISTS TO BE 11-7/8" TJI 210 @ 16" o.c. WITH 1-3/4" MIN BEARING, UNLESS NOTED OTHERWISE
- FLOOR DECK TO BE 3/4" TONGUE-AND-GROOVE, STRUCTURAL RATED PANEL (48/24
- CDX) UNLESS NOTED OTHERWISE. ALL LUMBER SHALL BE NO. 2 GRADE OR BETTER.
- ALL HEADERS AT EXTERIOR WALLS SHALL BE (2) 2x10 HF#2 OR BETTER w/ (2) JACK
- STUDS AT EACH END, UNLESS NOTED OTHERWISE.
- ALL LUMBER IN CONTACT w/ CONCRETE or MASONRY SHALL BE PRESSURE TREATED. FIREBLOCKING TO BE INSTALLED IN ALL WALL CAVITIES GREATER THAN 10 FEET TALL
- AND AS APPLICABLE PER CODE REQUIREMENTS (R602.8). PROVIDE BLOCKING AS NEEDED FOR ALL WALL MOUNTED EQUIPMENT, FURNISHINGS,
- CONFIRM STARTING POINT OF FLOOR FRAMING TO REDUCE CONFLICTS WITH
- PLUMBING- FRAMING CONTRACTOR TO VERIFY. PROVIDE GARAGE SHALL HAVE 5/8" TYPE 'X' GYP BD AT CEILING AND 1/2" GYP BD AT
- WALLS, UNLESS NOTED OTHERWISE. INTERIOR CEILINGS TO RECEIVE 5/8" GYP BD, UNLESS NOTED OTHERWISE. PROVIDE SELF-ADHERING ICE AND WATER PROTECTION MEMBRANE AT ALL EAVES TO
- A POINT 24" INSIDE THE EXTERIOR WALL FACE. WINDOWS IDENTIFIED AS "EGRESS" SHALL HAVE MINIMUM CLEAR WIDTH OF 20", MINIMUM CLEAR HEIGHT OF 22", AND MINIMUM CLEAR AREA OF 5.7 SQ FT. SILL
- HEIGHT TO BE 44" MAXIMUM ABOVE FLOOR. ALL PENETRATIONS GREATER THAN 100 SQ INCHES IN COMMON/SHARED GARAGE WALL SHALL BE UL1479 LISTED, UNLESS NOTED OTEHRWISE.

# **INSULATION REQUIREMENTS**

CONTRACTOR SHALL BE RESPONSIBLE FOR INSULATING THE RESIDENCE IN ACCORDANCE WITH THE 2012 INTERNATIONAL ENERGY CONSERVATION CODE (IECC) INCLUDING MONTANA AMENDMENTS.

### APPLICABLE PRESCRIPTIVE PATH REQUIREMENTS:

R-49 (UNCOMPRESSED R-38 ALLOWED AT EAVES) EXTERIOR WALL: R-21 (or R-13 + R-5 CONTINUOUS INSULATION) BASEMENT WALL: R-19 (or R-15 CONTINUOUS INSULATION) - SEÉ NOTE A SLAB PERIMETER: R-10 (or R-15 IF HEATED SLAB) CRAWLSPACE WALL: R-15 (or R-10 if RIGID INSULATION) WINDOW / DOOR: U-0.33 (R-3)

NOTE A: RES-CHECK ANALYSIS MAY ALLOW LOWER R-VALUE (R-10 MINIMUM)

### BRACED PANEL SCHEDULE

TYPE PANEL
A. 1/2" NOMINAL OSB
STUDS @ 16" o.c.
STUDS @ 16" o.c. B. 1/2" GWB- BOTH SIDES STUDS @ 16" o.c. MAX 1-1/4" SCREWS 4" o.c. (EDGE) & 8" o.c. (FIELD) C. 1/2" GWB- ONE SIDE STUDS @ 16" o.c. MAX 1-1/4" SCREWS 4" o.c. (EDGE) & 8" o.c. (FIELD)

NOTE: CONNECT ALL INTERIOR BRACED WALL PANELS TO FLOOR/ ROOF TRUSSES WITH 2-16d NAILS @ 16" O.C. PER IRC TABLE 602.3(2)

### **BEAM SCHEDULE**

- **RB1** 1 PIECE(S) 5 1/8" X 9" 24F-V4 DF GLULAM **RB2** 1 PIECE(S) 5 1/8" X 9" 24F-V4 DF GLULAM

**RB3** 1 PIECE(S) 5 1/8" X 10 1/2" 24F-V4 DF GLULAM

**GB1** 1 PIECE(S) 3 1/8" X 15" 24F-V4 DF GLULAM


PROJECT NUMBER: 1431 DRAWN BY / CHECKED BY: TPMP MAY 6, 2015 PHASE: **REVIEW SET** DRAWING TITLE:

MAIN FLOOR

DRAWING NUMBER:

REVISIONS:

NO. DESCRIPTION

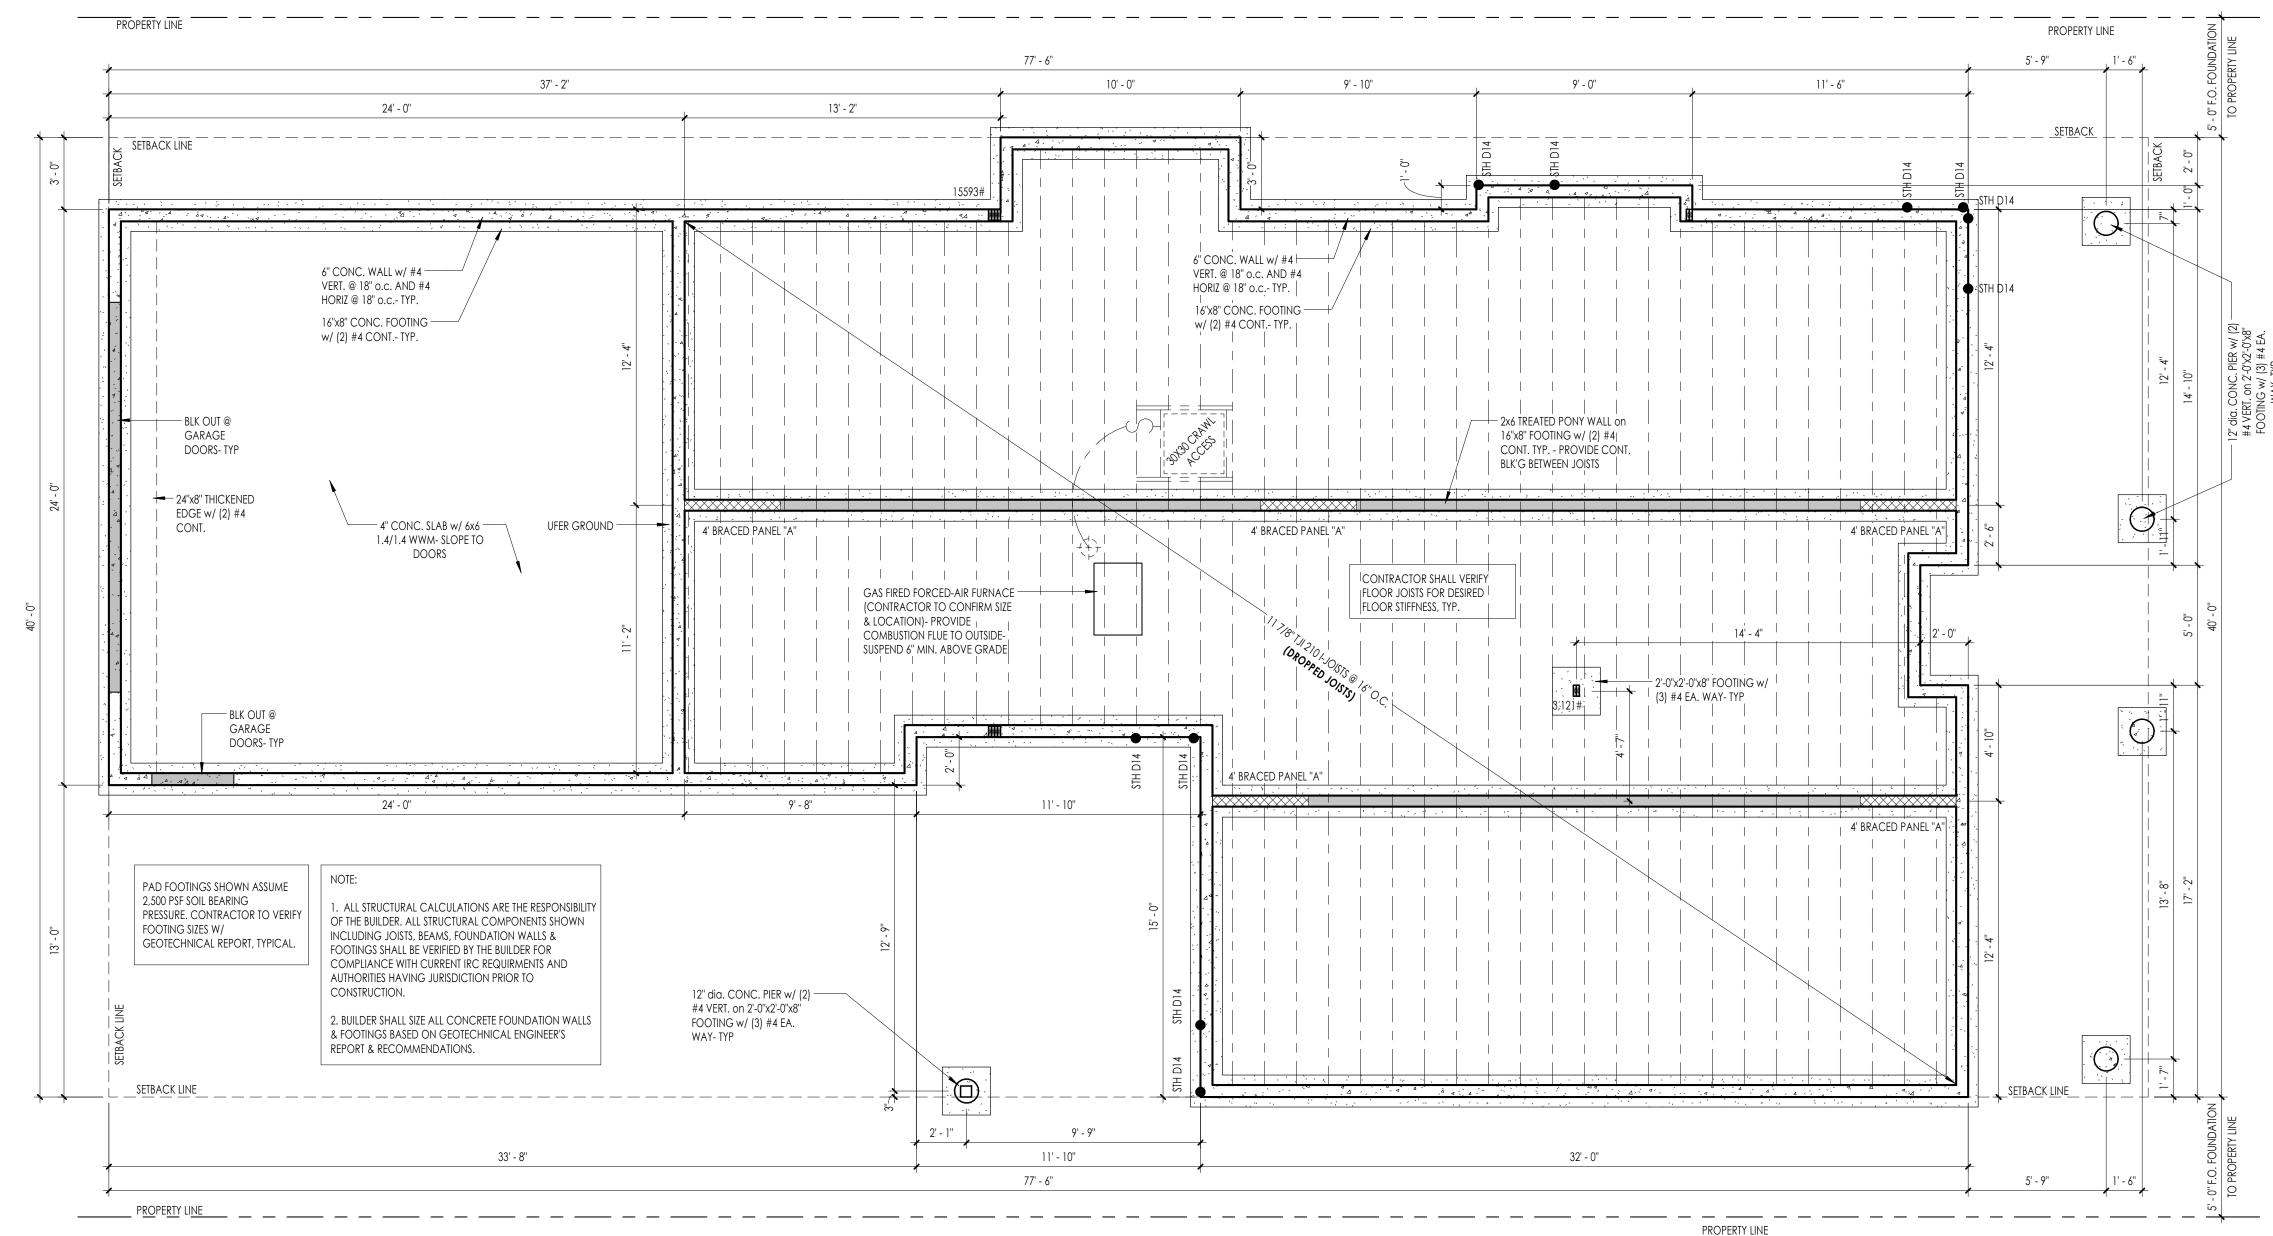

1 FOUNDATION 1/4" = 1'-0"

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CONSERVATION CODE (IECC)

- INTERIOR WALLS SHALL BE CONSTRUCTED OF 2x4 STUDS @ 16" o.c., UNLESS NOTED OTHERWISE. PROVIDE 2x6 WALLS AT ALL POCKET DOORS. INTERIOR WALLS TO RECEIVE 1/2" GYP BD, UNLESS NOTED OTHERWISE.
- FLOOR JOISTS TO BE 11-7/8" TJI 210 @ 16" o.c. WITH 1-3/4" MIN BEARING, UNLESS NOTED OTHERWISE
- FLOOR DECK TO BE 3/4" TONGUE-AND-GROOVE, STRUCTURAL RATED PANEL (48/24 CDX) UNLESS NOTED OTHERWISE.
- ALL LUMBER SHALL BE NO. 2 GRADE OR BETTER.
- ALL HEADERS AT EXTERIOR WALLS SHALL BE (2) 2x10 HF#2 OR BETTER w/ (2) JACK STUDS AT EACH END, UNLESS NOTED OTHERWISE
- ALL LUMBER IN CONTACT w/ CONCRETE or MASONRY SHALL BE PRESSURE TREATED.
- FIREBLOCKING TO BE INSTALLED IN ALL WALL CAVITIES GREATER THAN 10 FEET TALL AND AS APPLICABLE PER CODE REQUIREMENTS (R602.8).
- PROVIDE BLOCKING AS NEEDED FOR ALL WALL MOUNTED EQUIPMENT, FURNISHINGS,
- ). CONFIRM STARTING POINT OF FLOOR FRAMING TO REDUCE CONFLICTS WITH PLUMBING- FRAMING CONTRACTOR TO VERIFY.
- PROVIDE GARAGE SHALL HAVE 5/8" TYPE 'X' GYP BD AT CEILING AND 1/2" GYP BD AT
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NOTE A: RES-CHECK ANALYSIS MAY ALLOW LOWER R-VALUE (R-10 MINIMUM)

## **FOUNDATION NOTES**

WINDOW / DOOR: U-0.33 (R-3)

- FOOTINGS ARE TO BEAR ON UNDISTURBED, LEVEL SOIL DEVOID OF ANY ORGANIC
- STEP FOOTINGS AS NEEDED TO MAINTAIN REQUIRED DEPTH BELOW FINAL GRADE. ALL GRANULAR FILL SHALL BE COMPACTED TO 95% DENSITY, UNLESS NOTED
- SLOPE FLOOR OF GARAGE TO OPENING(S) AT 1/8" PER FOOT MINIMUM.
- CONCRETE SLABS ON GRADE SHALL HAVE CONTROL JOINTS AT MIMIMUM 12' INTERVALS EACH WAY, UNLESS NOTED OTHERWISE.
- CONCRETE SIDEWALKS TO HAVE TOOLED 3/4" JOINT AT 5' INTERVALS, UNLESS NOTED
- REINFORCING STEEL SHALL BE A-615 GRADE 60. PROVIDE MINIMUM 40 BAR DIAMETER
- LAP AT SPLICES, CORNERS, AND INTERSECTIONS. ALL WOOD IN CONTACT WITH CONCRETE SHALL BE PRESSURE TREATED.
- DAMPPROOF FOUNDATION BEFORE BACKFILLING.

## BRACED PANEL SCHEDULE

TYPE PANEL
A. 1/2" NOMINAL OSB STUDS @ 16" o.c. 8d NAILS SPACING
6" o.c. (EDGE) & 12" o.c. (FIELD)

B. 1/2" GWB- BOTH SIDES STUDS @ 16" o.c. MAX 1-1/4" SCREWS 4" o.c. (EDGE) & 8" o.c. (FIELD) C. 1/2" GWB- ONE SIDE STUDS @ 16" o.c. MAX 1-1/4" SCREWS 4" o.c. (EDGE) & 8" o.c. (FIELD)

NOTE: CONNECT ALL INTERIOR BRACED WALL PANELS TO FLOOR/ ROOF TRUSSES WITH 2-16d NAILS @ 16" O.C. PER IRC TABLE 602.3(2)

**IRONWOOD DEVELOPMENT** 406-581-9999

1059 N 12TH AVE. BLOCK 1, LOT 13 OAK MEADOWS SUB. **BOZEMAN MT** 

REVISIONS:

NO. DESCRIPTION

PROJECT NUMBER: DRAWN BY / CHECKED BY: TPMP

DATE: APRIL 7, 2015


PHASE: **REVIEW SET** 


1431


DRAWING TITLE: **FOUNDATION** 


DRAWING NUMBER:



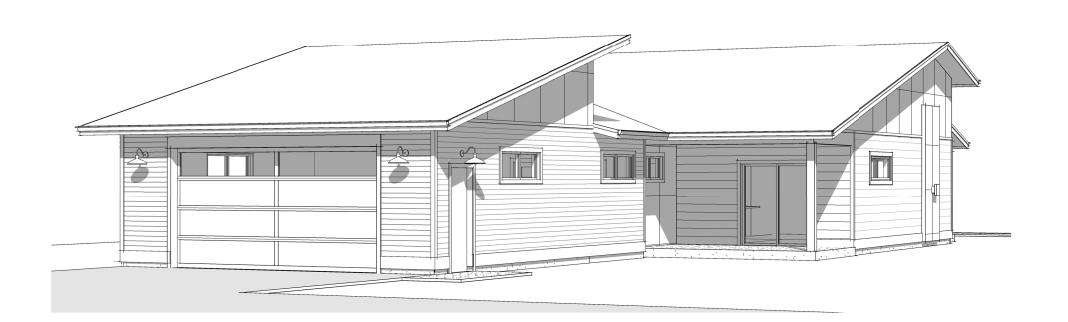


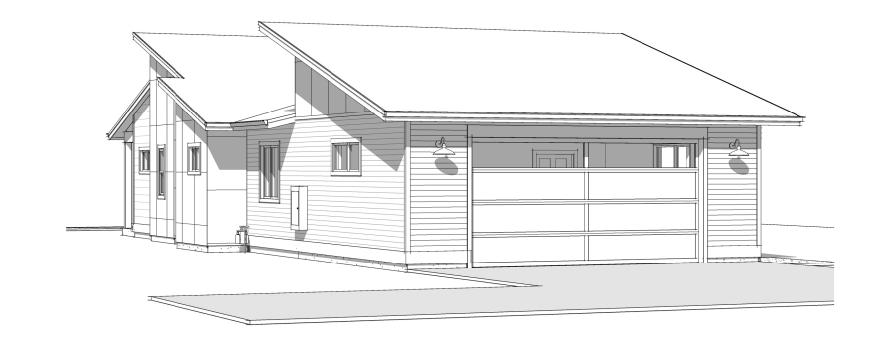


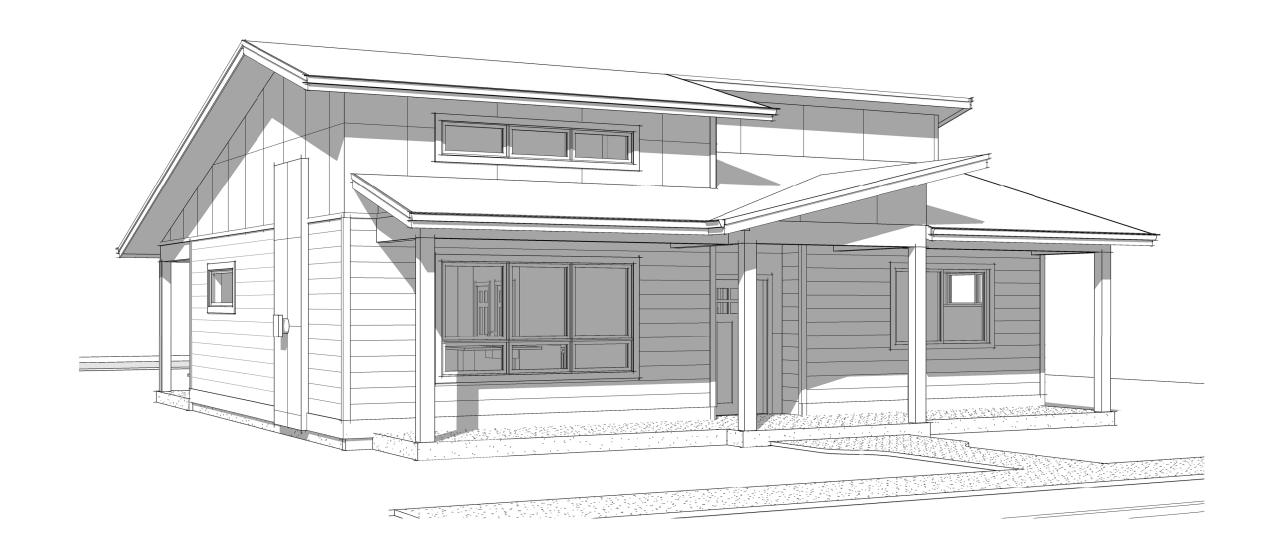


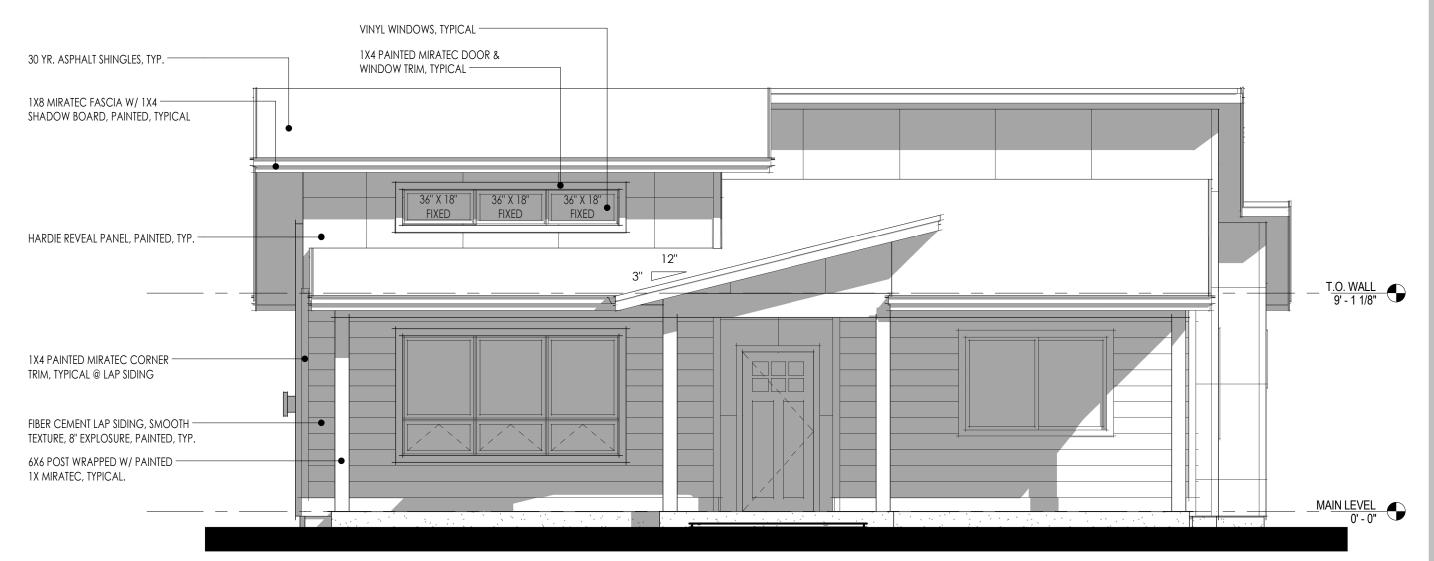

1 WEST 1/4" = 1'-0"

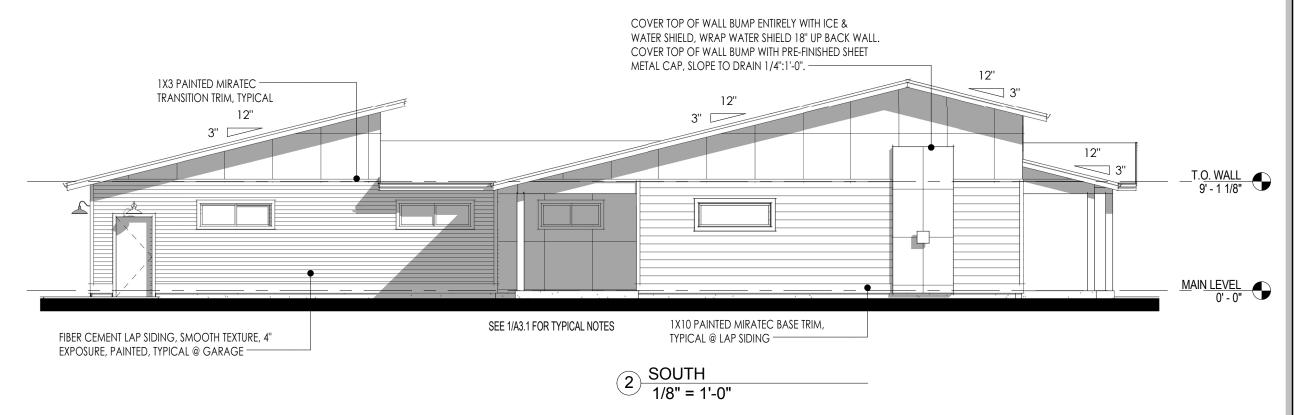

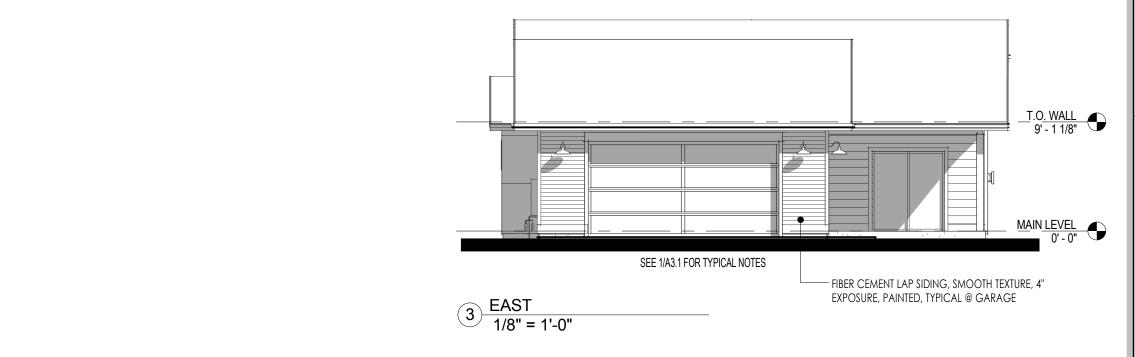

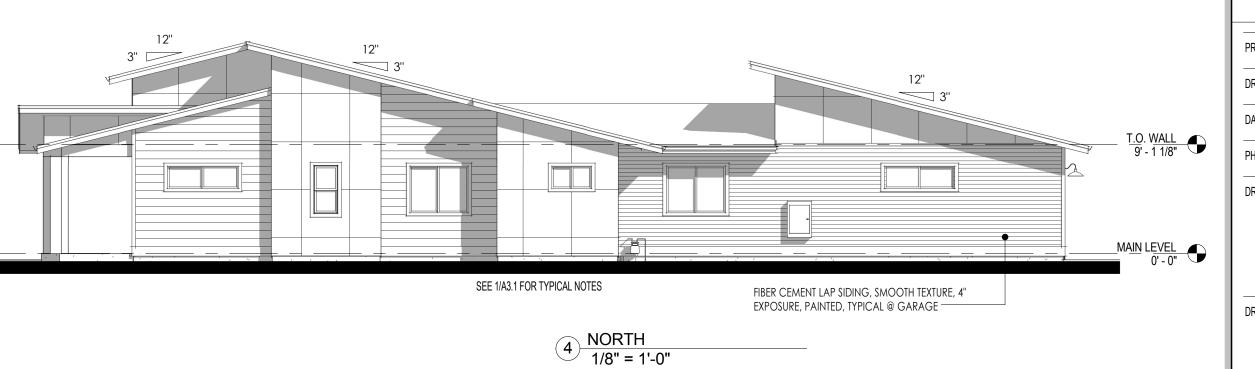

IRONWOOD DEVELOPMENT 406-581-9999

1059 N 12TH AVE. BLOCK 1, LOT 13 OAK MEADOWS SUB. BOZEMAN MT

REVISIONS:

NO. DESCRIPTION DATE

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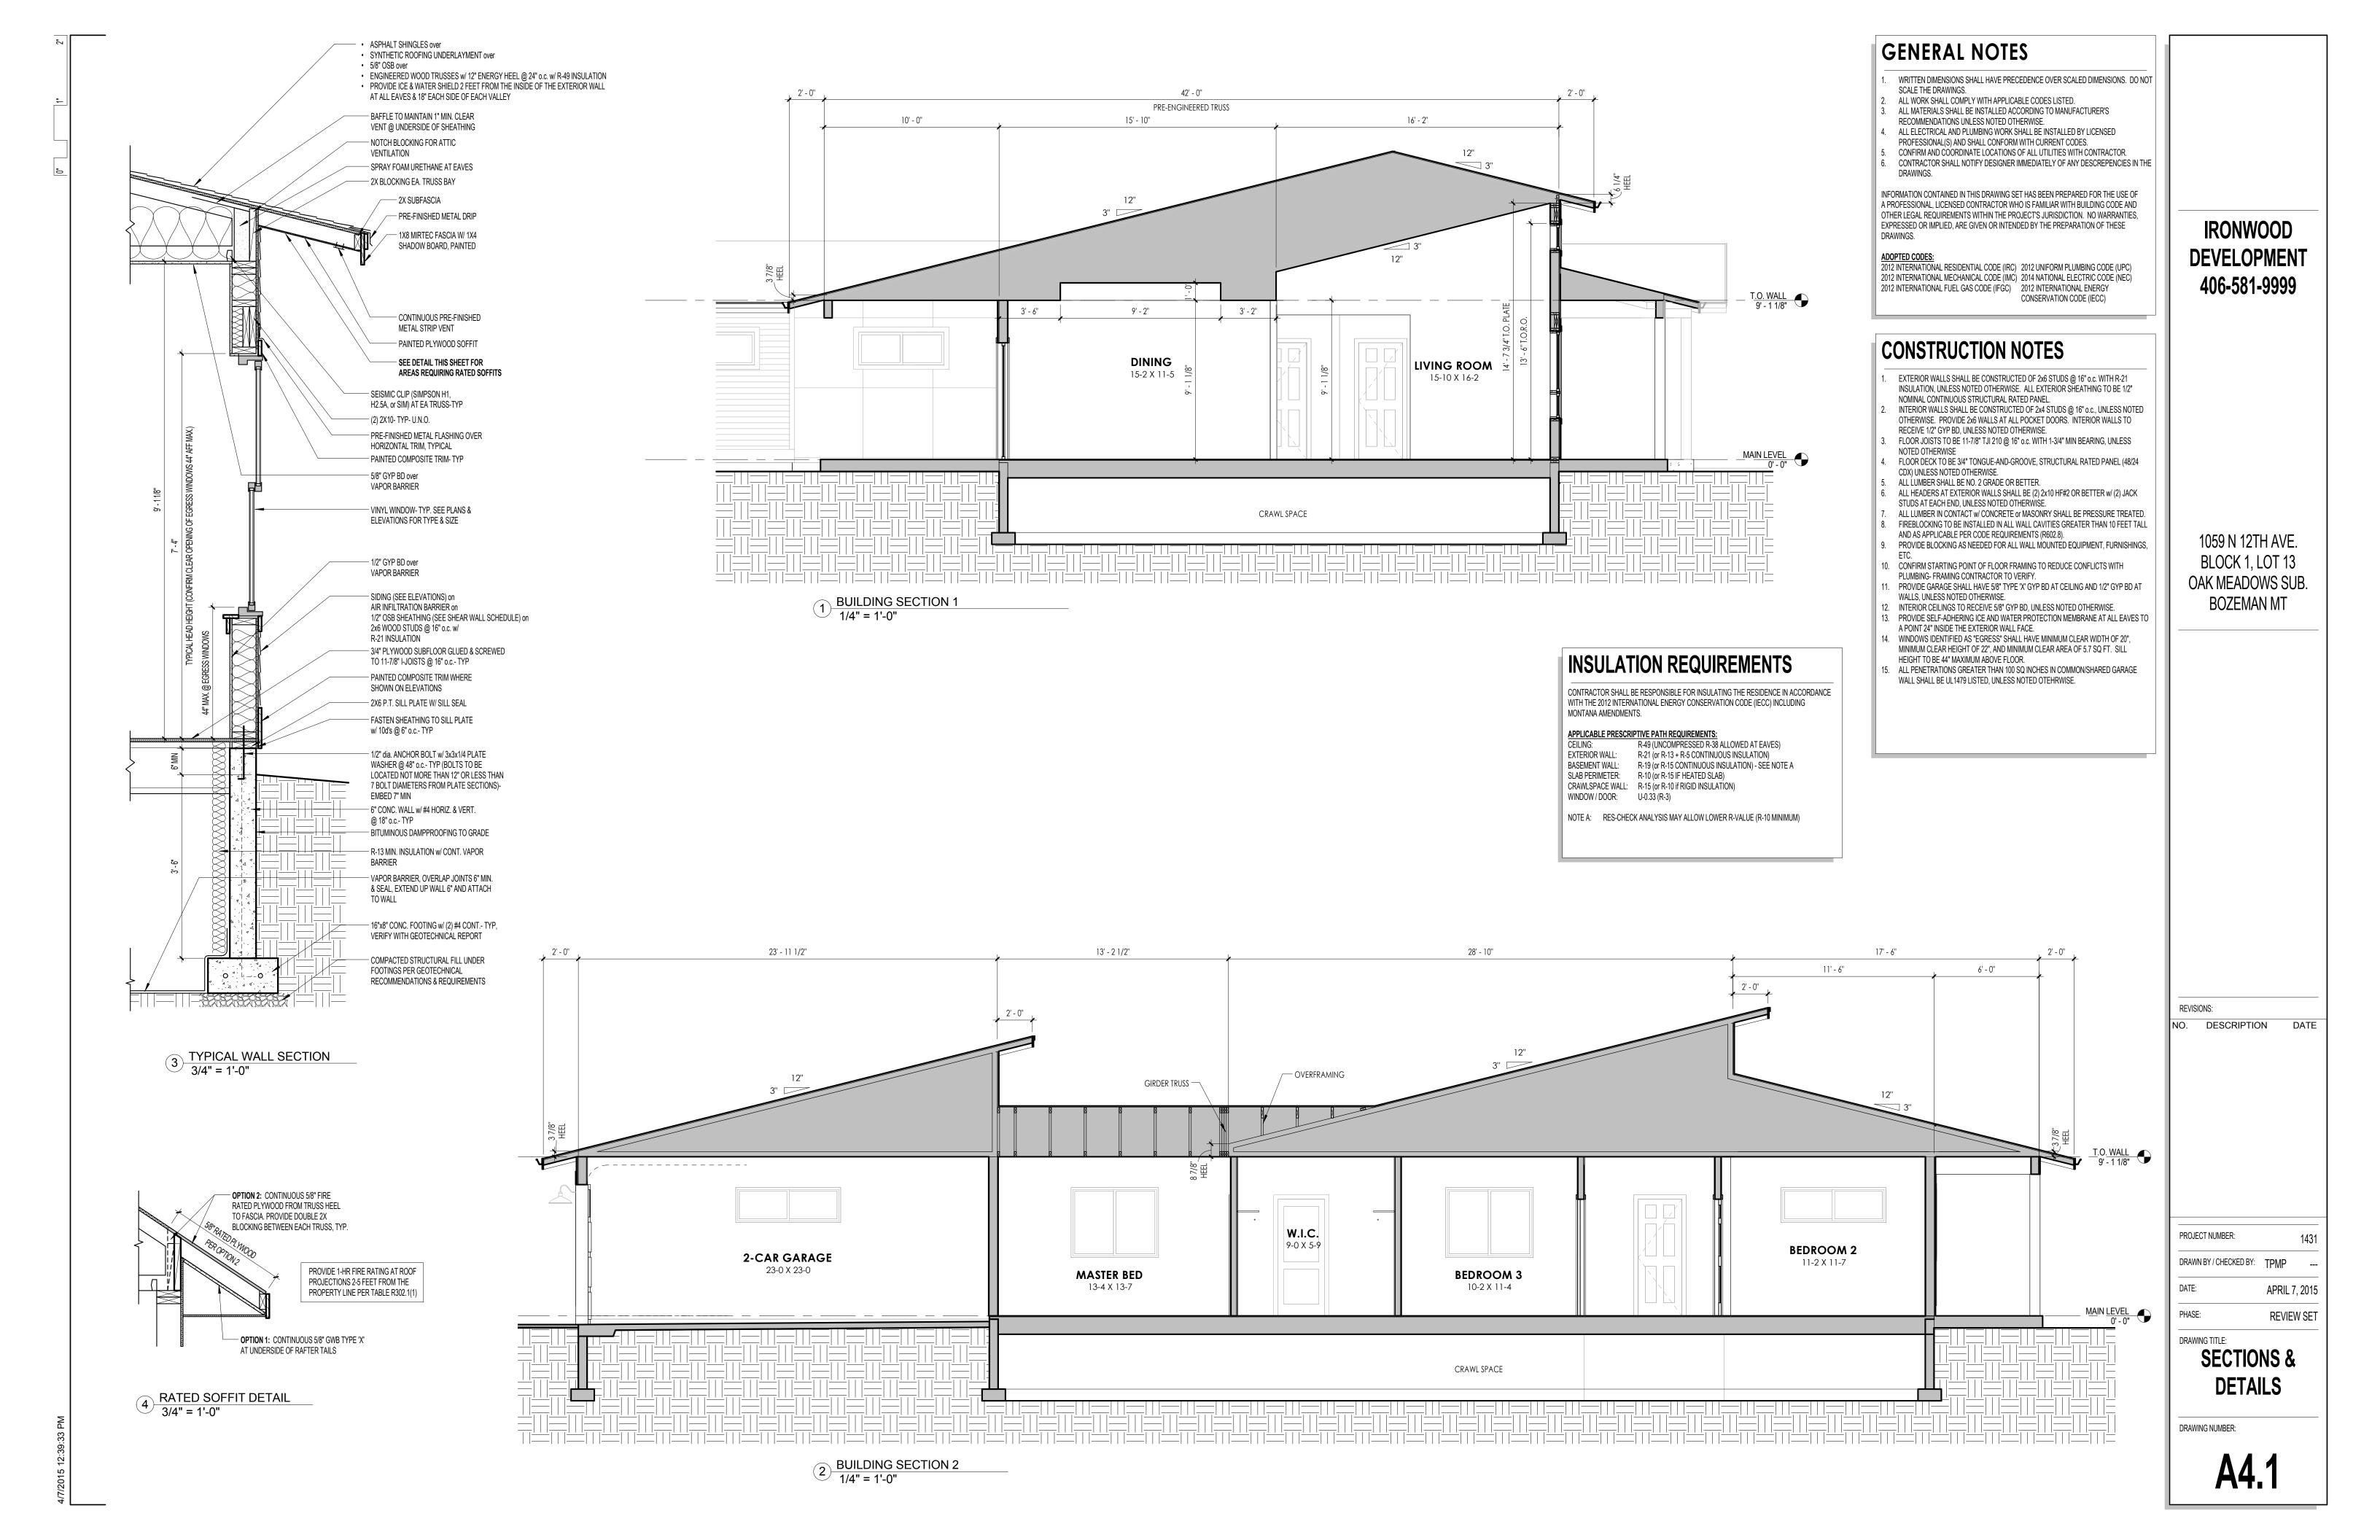
DRAWN BY / CHECKED BY: TPMP --
DATE: APRIL 7, 2015

PHASE: REVIEW SET

**ELEVATIONS** 

DRAWING NUMBER:

A3.1



# LEGEND - ELECTRICAL SYMBOLS

- LIGHT FIXTURE RECESSED
- LIGHT FIXTURE SURFACE MOUNTED
- LIGHT FIXTURE WALL MOUNTED
- LIGHT FIXTURE PENDANT
- EXHAUST FAN or FAN/LIGHT COMBINATION
- CEILING FAN or FAN/LIGHT COMBINATION

### (SD) SMOKE DETECTOR

- DUPLEX OUTLET "G":GFI "WP":WEATHERPROOF

  ALL OUTLETS TO BE "AFCI" PROTECTED and TAMPERPROOF UNLESS NOTED
- OTHERWISE
- WALL SWITCH
- 1. ALL ELECTRICAL WORK SHALL BE INSTALLED BY A LICENSED ELECTRICIAN AND SHALL CONFORM WITH CURRENT CODES.
- VERIFY ALL FIXTURE TYPES AND LOCATIONS WITH OWNER AND/OR CONTRACTOR. VERIFY ALL SWITCH TYPES AND LOCATIONS WITH OWNER AND/OR CONTRACTOR.
- 4. COORDINATE AND PROVIDE RECEPTACLES FOR ALL MAJOR APPLIANCES. PROVIDE TELEPHONE AND TELEVISION CABLE JACKS AS DIRECTED BY OWNER
- AND/OR CONTRACTOR. RECEPTACLES SHALL BE PLACED SO THAT NO POINT MEASURED HORIZONTALLY ALONG THE FLOOR LINE IN ANY WALL SPACE IS MORE THAN 6' FROM A
- RECEPTACLE OUTLET. . LIGHT FIXTURES SHALL BE MOUNTED 12" MINIMUM FROM NEAREST POINT OF
- STORAGE SPACE. PROVIDE 30" x 36" CLEAR WORK AREA CENTERED IN FRONT OF ELECTRICAL PANEL(S) AND ELECTRICAL SERVICE ENTRY POINT (METER LOCATION).

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1059 N 12TH AVE. BLOCK 1, LOT 13 OAK MEADOWS SUB. **BOZEMAN MT** 

REVISIONS:

NO. DESCRIPTION

PROJECT NUMBER: DRAWN BY / CHECKED BY: TPMP

MAY 6, 2015

DRAWING TITLE: **ELECTRICAL** 

**REVIEW SET** 

DRAWING NUMBER:

